

VICINITY MAP:



LANDSCAPE SHEET INDEX:

SHEET NUMBER	Sheet name	SCALE	CITY CHECK SET REVIEW SUBMITTAL - 2022,00,00
LS-100	Landscape Sheet Key Plan	N.T.S.	•
LS-101 LS-102 LS-103	Site Layout Plan Hardscape Plan and Details Grading Plan	1" = 20' 1" = 20' 1" = 20'	•
LS-104	Planting Plan	1" = 20'	•
LS-501	Planting Details and Notes	As Noted	•

GENERAL NOTES:

1. CONTRACTOR TO COORDINATE WITH THE CITY'S ENGINEERING DEPARTMENT TO VERIFY ALL EXISTING AND PROPOSED SPOT GRADES AND ELEVATIONS FOR THIS PROJECT.

2. THE LOCATION OF ALL EXISTING UTILITIES SHOWN ON THE PLANS HAVE BEEN DETERMINED FROM THE BEST INFORMATION AVAILABLE AND ARE GIVEN FOR THE CONVENIENCE OF THE CONTRACTOR/SUBCONTRACTOR. IT SHALL BE THE CONTRACTOR'S/SUBCONTRACTOR'S RESPONSIBILITY TO NOTIFY THE VARIOUS UTILITIES AND TO MAKE THE NECESSARY ARRANGEMENTS FOR ANY RELOCATIONS OF THESE UTILITIES WITH THE OWNER OF THE UTILITY. THE CONTRACTOR/SUBCONTRACTOR SHALL EXERCISE CAUTION WHEN CROSSING ANY UNDERGROUND UTILITY, WHETHER SHOWN ON THE PLANS OR LOCATED BY THE UTILITY COMPANY. ALL UTILITIES WHICH INTERFACE WITH THE PROPOSED CONSTRUCTION SHALL BE RELOCATED BY THE RESPECTIVE UTILITY COMPANIES.

3. ALL WORK SHALL BE ACCOMPLISHED IN ACCORDANCE WITH THE PLANS AND GENERAL NOTES CONTAINED HEREIN AND/OR OTHERWISE REQUIRED BY APPLICABLE FEDERAL, STATE, AND LOCAL CODES, ORDINANCES, AND REGULATIONS. IN THE EVENT OF A CONFLICT BETWEEN THE REQUIREMENTS, THE MOST STRINGENT SHALL APPLY AS DETERMINED

4. THE CONTRACTOR IS RESPONSIBLE FOR REPAIRING ANY DAMAGE TO EXISTING FACILITIES, ABOVE OR BELOW GROUND, THAT MAY OCCUR AS A RESULT OF THE WORK PERFORMED. ALL DAMAGED FACILITIES ARE TO BE RESTORED TO ORIGINAL CONDITION AT THE CONTRACTOR'S EXPENSE.

5. IT IS THE CONTRACTOR'S RESPONSIBILITY TO BECOME FAMILIAR WITH THE PERMIT AND INSPECTION REQUIREMENTS OF THE VARIOUS GOVERNMENTAL AGENCIES. THE

CONTRACTOR SHALL OBTAIN ALL NECESSARY PERMITS PRIOR TO CONSTRUCTION, AND SCHEDULE INSPECTIONS ACCORDING TO AGENCY INSTRUCTION.

6. ALL SPECIFICATIONS AND DOCUMENTS REFERRED TO SHALL BE OF THE LATEST REVISIONS AND/OR LATEST EDITION.

7. MATERIALS AND INSTALLATION SHALL BE IN ACCORDANCE WITH THE APPLICABLE STANDARDS AND THE CITY OF NEW PORT RICHEY STANDARD DETAILS.

8. WORK PERFORMED UNDER THIS CONTRACT SHALL INTERFACE SMOOTHLY WITH OTHER WORK BEING PERFORMED ON SITE BY OTHER CONTRACTORS AND UTILITY COMPANIES. IT WILL BE NECESSARY FOR THE CONTRACTOR TO COORDINATE AND SCHEDULE ACTIVITIES, WHERE NECESSARY, WITH OTHER CONTRACTORS AND UTILITY COMPANIES.

9. ALL DISTURBED AREAS WITHIN PUBLIC RIGHT-OF-WAY OR OUTSIDE THE PROJECT BOUNDARY ARE TO BE RESTORED TO ORIGINAL CONDITION OR BETTER.

10. REPAIR AND REPLACEMENT OF ALL PRIVATE AND PUBLIC PROPERTY AFFECTED BY THIS WORK SHALL BE RESTORED TO A CONDITION EQUAL TO OR BETTER THAN EXISTING CONDITIONS AT CONTRACTOR'S EXPENSE.

11. ALL DISTURBED AREAS ASSOCIATED WITH CONSTRUCTION, WHICH ARE NOT TO BE SODDED, ARE TO BE SEEDED TO GOVERNING AGENCY STANDARDS AND SHOULD PRESENT A FINISHED APPEARANCE AND REASONABLY COMPLETE COVERAGE WITHIN ONE YEAR OF PLANTING. ANY WASHOUTS, REGRADING, RESEEDING, AND GRASSING WORK, AND OTHER EROSION WORK REQUIRED, WILL BE PERFORMED BY THE CONTRACTOR/SUBCONTRACTOR UNTIL THE SYSTEM IS ACCEPTED FOR MAINTENANCE BY THE REGULATORY

GENERAL CONSTRUCTION NOTES:

1. THE CONTRACTOR SHALL COMPLY WITH ALL APPLICABLE LOCAL, STATE AND FEDERAL GUIDELINES AND BUILDING CODES.

2. THE CONTRACTOR SHALL VERIFY LOCATION OF ALL UTILITIES, EXISTING TREES, EXISTING PALMS, AND EXISTING LIGHT FIXTURES IN RELATION TO THE PROPOSED DESIGN PRIOR TO BEGINNING CONSTRUCTION.

3. THE CONSTRUCTION SITE SHALL BE LEFT CLEAN AND FREE FROM DEBRIS AT THE END OF EACH WORK DAY.

4. THE CONTRACTOR SHALL APPLY FOR, OBTAIN AND PAY FOR ALL REQUIRED PERMITS, UNLESS OTHERWISE SPECIFIED. PERMITS SHALL BE POSTED ACCORDING TO LOCAL, STATE AND FEDERAL REGULATIONS.

5. ALL WORK, MATERIAL AND EQUIPMENT UTILIZED SHALL BE INSTALLED IN STRICT ACCORDANCE WITH THE MANUFACTURER'S RECOMMENDATIONS AND SPECIFICATIONS.

6. ALL WORK FOR THIS PROJECT SHALL CONFORM TO STANDARDS PUBLISHED BY RECOGNIZED PROFESSIONAL AND INDUSTRY ORGANIZATIONS. 7. THE CONTRACTOR SHALL BE RESPONSIBLE FOR VISITING THE SITE AND BECOMING FAMILIAR WITH ALL EXISTING CONDITIONS AFFECTING THE WORK PRIOR TO BIDDING.

8. THE CONTRACTOR SHALL SUBMIT UNIT PRICES FOR ALL LINE ITEMS IN THEIR BID.

9. THE CONTRACTOR SHALL SEEK CLARIFICATION PRIOR TO BIDDING FROM THE OWNER'S REP. OF ANY DISCREPANCIES IN THE PROVIDED DRAWINGS. THE MOST STRINGENT REQUIREMENTS SHALL APPLY.

AFFECT SUBMISSION OF A COMPLETE AND ACCURATE BID. SUBMISSION OF QUESTIONS SHALL CONFORM TO THE REQUIREMENTS SET FORTH IN THE INSTRUCTION TO BIDDERS.

10. THE CONTRACTOR SHALL SEEK CLARIFICATION PRIOR TO BIDDING OF ANY QUESTIONS CONCERNING CONDITIONS, DRAWINGS, DETAILS AND SPECIFICATIONS THAT WILL

11. THE CONTRACTOR SHALL OBTAIN WRITTEN APPROVAL FROM THE OWNER'S REP. FOR ANY DEVIATION FROM THE CONTRACT DOCUMENTS.

12. ALL REQUESTS FOR INFORMATION CLARIFICATION, DEVIATION OR SUBSTITUTION FOR ITEMS IN THE CONTRACT DOCUMENTS SHALL BE MADE IN WRITING THROUGH THE OWNER'S REP. THE OWNER'S REP. SHALL HAVE SEVEN (7) WORKING DAYS IN WHICH TO RESPOND.

13. THE CONTRACTOR SHALL BE RESPONSIBLE FOR PREPARING AND MAINTAINING ALL CONSTRUCTION AREAS FREE OF DEBRIS AND HAZARDOUS MATERIALS THROUGHOUT THE

14. THE CONTRACTOR SHALL BE RESPONSIBLE FOR THE REPAIR AND/OR REPLACEMENT OF ANY ITEMS/AREAS DAMAGED DURING THE CONSTRUCTION OUTSIDE OF NORMAL

PRACTICES AT NO COST TO THE CLIENT.

15. THE CONTRACTOR SHALL LAYOUT AND VERIFY ALL DIMENSIONS IN THE FIELD PRIOR TO THE START OF CONSTRUCTION. REPORT ANY DISCREPANCIES IMMEDIATELY TO THE

16, DIMENSIONS SHALL NOT BE SCALED FROM THE CONTRACT DOCUMENTS, WRITTEN DIMENSIONS SHOWN ON THE PLANS SHALL RULE. IN THE CASE OF AMBIGUITY THE

CONTRACTOR SHALL REQUEST IN WRITING A CLARIFICATION OF DIMENSIONS FROM THE OWNER'S REP. 17. WHERE THERE IS A DISCREPANCY BETWEEN THE QUANTITY SHOWN ON THE MATERIAL LIST AND THE QUANTITY OF ITEMS SHOWN ON THE PLANS, THE PLANS SHALL RULE.

18. THE CONTRACTOR SHALL SUBMIT SHOP DRAWINGS FOR APPROVAL PRIOR TO THE START OF FABRICATION FOR ALL APPLICABLE ITEMS. THE OWNER'S REP. SHALL HAVE SEVEN (7) WORKING DAYS IN WHICH TO RESPOND.

19. ANY INFRASTRUCTURE, STRUCTURAL ELEMENTS, OR UTILITIES ARE SHOWN FOR REFERENCE ONLY. CONTRACTOR TO PROVIDE SIGNED AND SEALED DWGS. FOR ALL STRUCTURAL AND UTILITY WORK, LOCATION OF ANY CONDUIT MUST BE COORDINATED WITH OWNER'S REP. ANY DISCREPANCIES SHALL BE BROUGHT TO THE ATTENTION OF THE

20. DIMENSIONS ARE TO WALL, STAIR FACES, FACE OF CURB, AND EDGE OF WALK UNLESS INDICATED OTHERWISE ON DRAWINGS.

21, MAINTAIN EXISTING GRADE AT THE BASE OF ALL EXISTING TREES TO REMAIN. INSTALL TREE PROTECTION FENCING AT THE DRIPLINE OF ALL TREES TO REMAIN WHEN POSSIBLE. PROTECT FROM PHYSICAL DAMAGE, STOCKPILING OR CONSTRUCTION TRAFFIC WITHIN THE DRIPLINE.

EQUIPMENT

EACH WAY

EXISTING

FACE OF

GAUGE

FLOOR DRAIN

FACE OF FINISH

FLORIDA BUILDING CODE

FINISH FLOOR ELEVATION

22. CONTRACTOR TO CONSTRUCT ALL CURVILINEAR SITE ELEMENTS WITH SMOOTH, CONTINUOUS, UNBROKEN CURVES.

E.Q.

EW

FFE

F.O.

EQUIP.

MECH.

NOM.

EQUIP.

DETAIL NUMBER XX-### SHEET NUMBER XX-###	SECTION
DETAIL NUMBER SHEET NUMBER X X X X X X X X X X X X X	DETAIL
DRAWING TITLE DRAWING NUMBER DRAWING SCALE # XX XX	DRAWING TITLE
X XX-###	SECTION/AREA ENLARGEMENT

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DETAIL NUMBER	X XX—###	DETAIL
DRAWING TITLE ————————————————————————————————————	—	DRAWING TITLE
	X XX-###	SECTION/AREA ENLARGEMENT

OWNER'S REP.

	SECTION	
	DETAIL	
XX XX	DRAWING TITLE	
X XX-###	SECTION/AREA ENLARGEMENT	

ABBREVIATIONS:

	710011
	Ø
	+/-
	xx°
	@
	&
	A.C.
	ADJ.
	ALUM.
	ARCH.
	A.F.F.
	APPROX.
	BLDG.
	BS
	BW
	CB
	CL
	CNTRL.
	C.O.
	COL.
	CONC.
	CONST.
	CONT.
	C.M.U.
	DD
RGEMENT	DET.
INCLIVILIA	DI
	DIA.
	DIM.
	DN.
	DR.
	DWG

Ø	DIAMETER
+/-	PLUS/MINUS
xx°	DEGREES
@	AT
&	AND
A.C.	AIR CONDITIONER
ADJ.	ADJACENT
ALUM.	ALUMINUM
ARCH.	ARCHITECTURE, ARCHITECT
A.F.F.	ABOVE FINISH FLOOR
APPROX.	APPROXIMATE
BLDG.	
BS	BOTTOM OF STAIR/STEP
BW	BOTTOM OF WALL
СВ	CATCH BASIN
CL	CENTERLINE
CNTRL.	CONTROL
C.O.	CLEAN OUT
COL.	COLUMN
CONC.	CONCRETE
CONST.	CONSTRUCTION
CONT.	CONTINUOUS
C.M.U.	CONCRETE MASONRY UNIT
DD	DECK DRAIN
DET.	DETAIL
DI	DRAIN INLET
DIA.	DIAMETER
DIM.	DIMENSION
DN.	DOWN

DD	DECK DRAIN
DET.	DETAIL
)I	DRAIN INLET
DIA.	DIAMETER
DIM.	DIMENSION
ON.	DOWN
DR.	DOOR
OWG	DRAWING
ΞJ	EXPANSION JOINT
ELEC.	ELECTRIC, ELECTRIC
ΞL	ELEVATION

GALV. GALVANIZED GEN. **GENERATOR** HANDICAP HORIZONTAL HFIGHT H.A. HIGH POINT JOINT LOW POINT MANUF

NO. or # NUMBER

NOMINAL

N.T.S. NOT TO SCALE

LANDSCAPE ARCHITECT LINEAR FEET MANUFACTURER MECHANICAL MECHANICAL/ELECTRICAL/PLUMBING METAL MANHOLE MINIMUM MISCELLANEOUS NOT IN CONTRACT

N.G.V.D. NATIONAL GEODETIC VERTICAL DATUM

TYPICAL **VERTICAL** VERIFY IN FIELD WITH WITHOUT WATERPROOF

ON CENTER

OPPOSITE

PRESSURE

ROOF DRAIN

REINFORCED

SQUARE FEET

SPECIFICATIONS

SYMMETRICAL

TO BE REMOVED

TOP OF COLUMN

TOP AND BOTTOM

TOP OF STAIR/STEP

TRANSVERSE

TOP OF WALL

STRUCTURAL

REQUIRED

SIMILAR

SQUARE STAINLESS STEEL

TREAD

TOP OF

SPECS.

STRUC.

RADIUS

OUTSIDE DIAMETER

POINT OF BEGINNING

PLANTING AREA

COVER SHEET

Project No.: 215616802

File Name: 215616802- LS-100-COVER SHEET

 MS
 MS
 LG
 2021.02.22

 Dwn.
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 Chkd.
 YYYY.MM.DD

Scale: As Noted

Permit/Seal

PRELIMINARY

NOT FOR


CONSTRUCTION


Not for permits, pricing or other official


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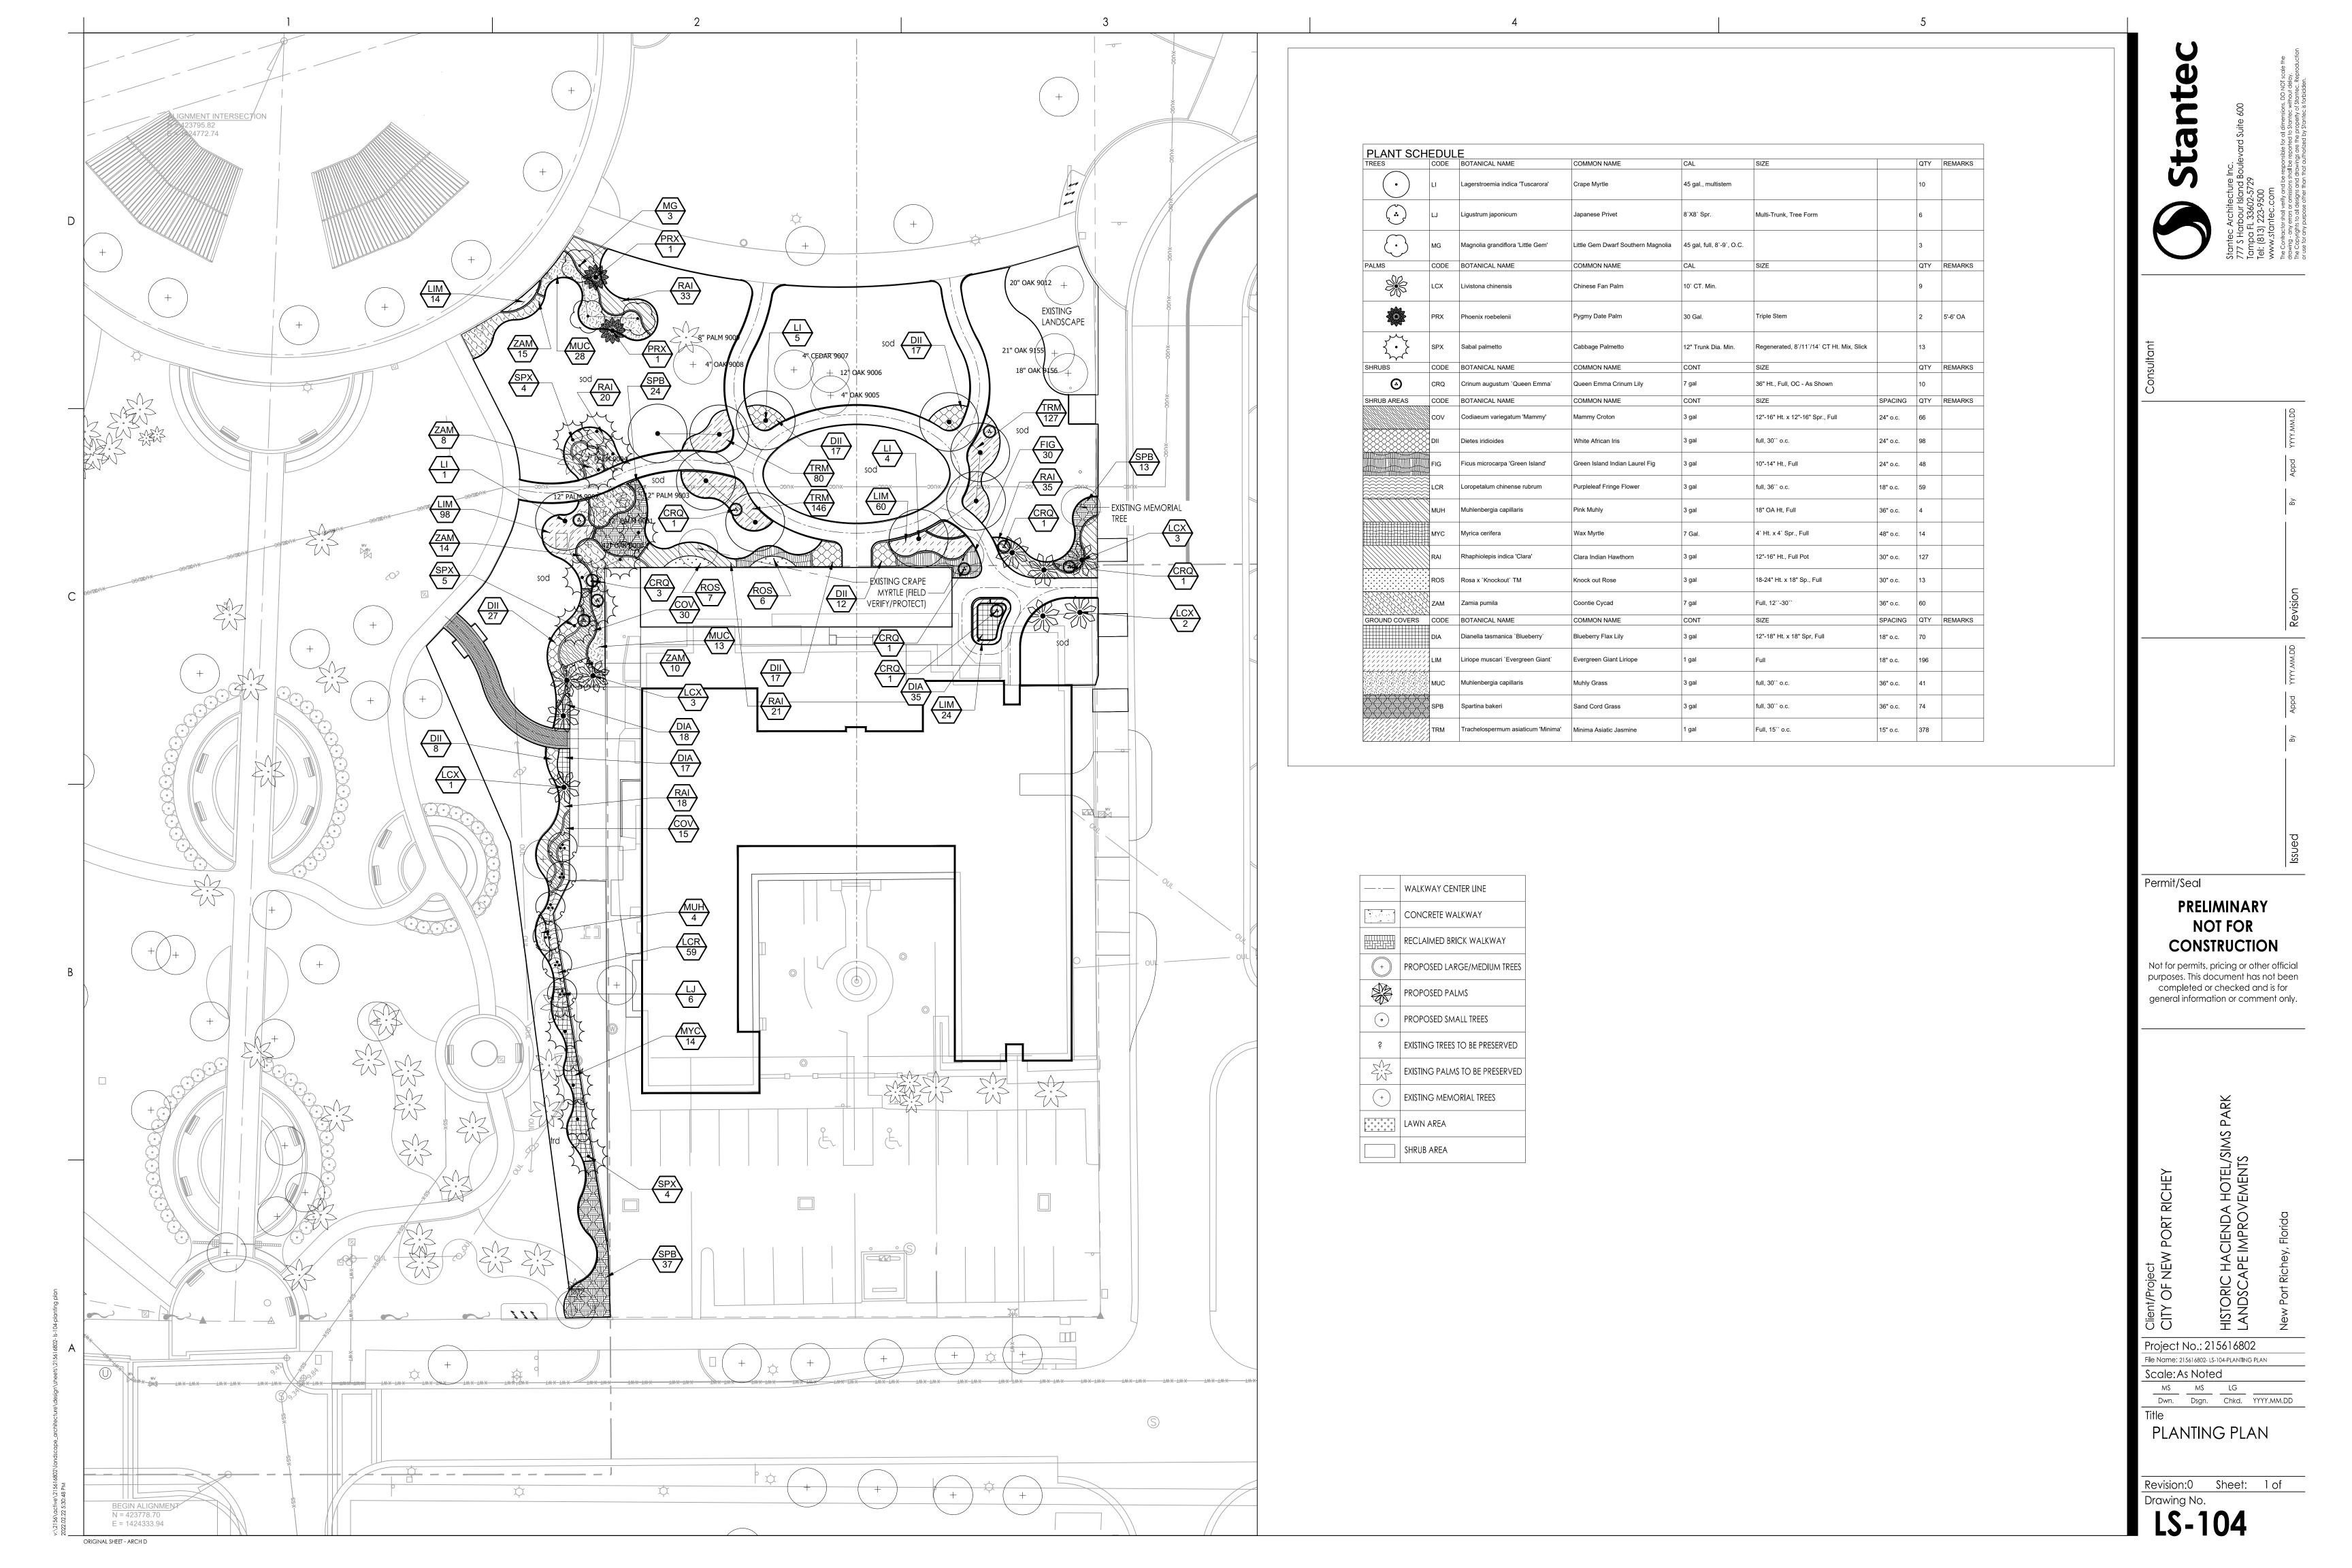
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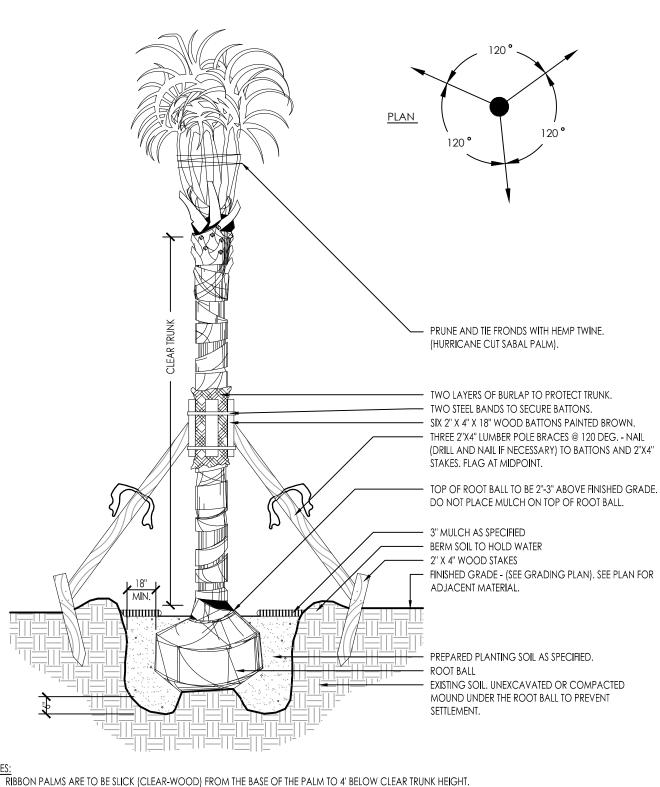
Revision:0 Sheet: 1 of





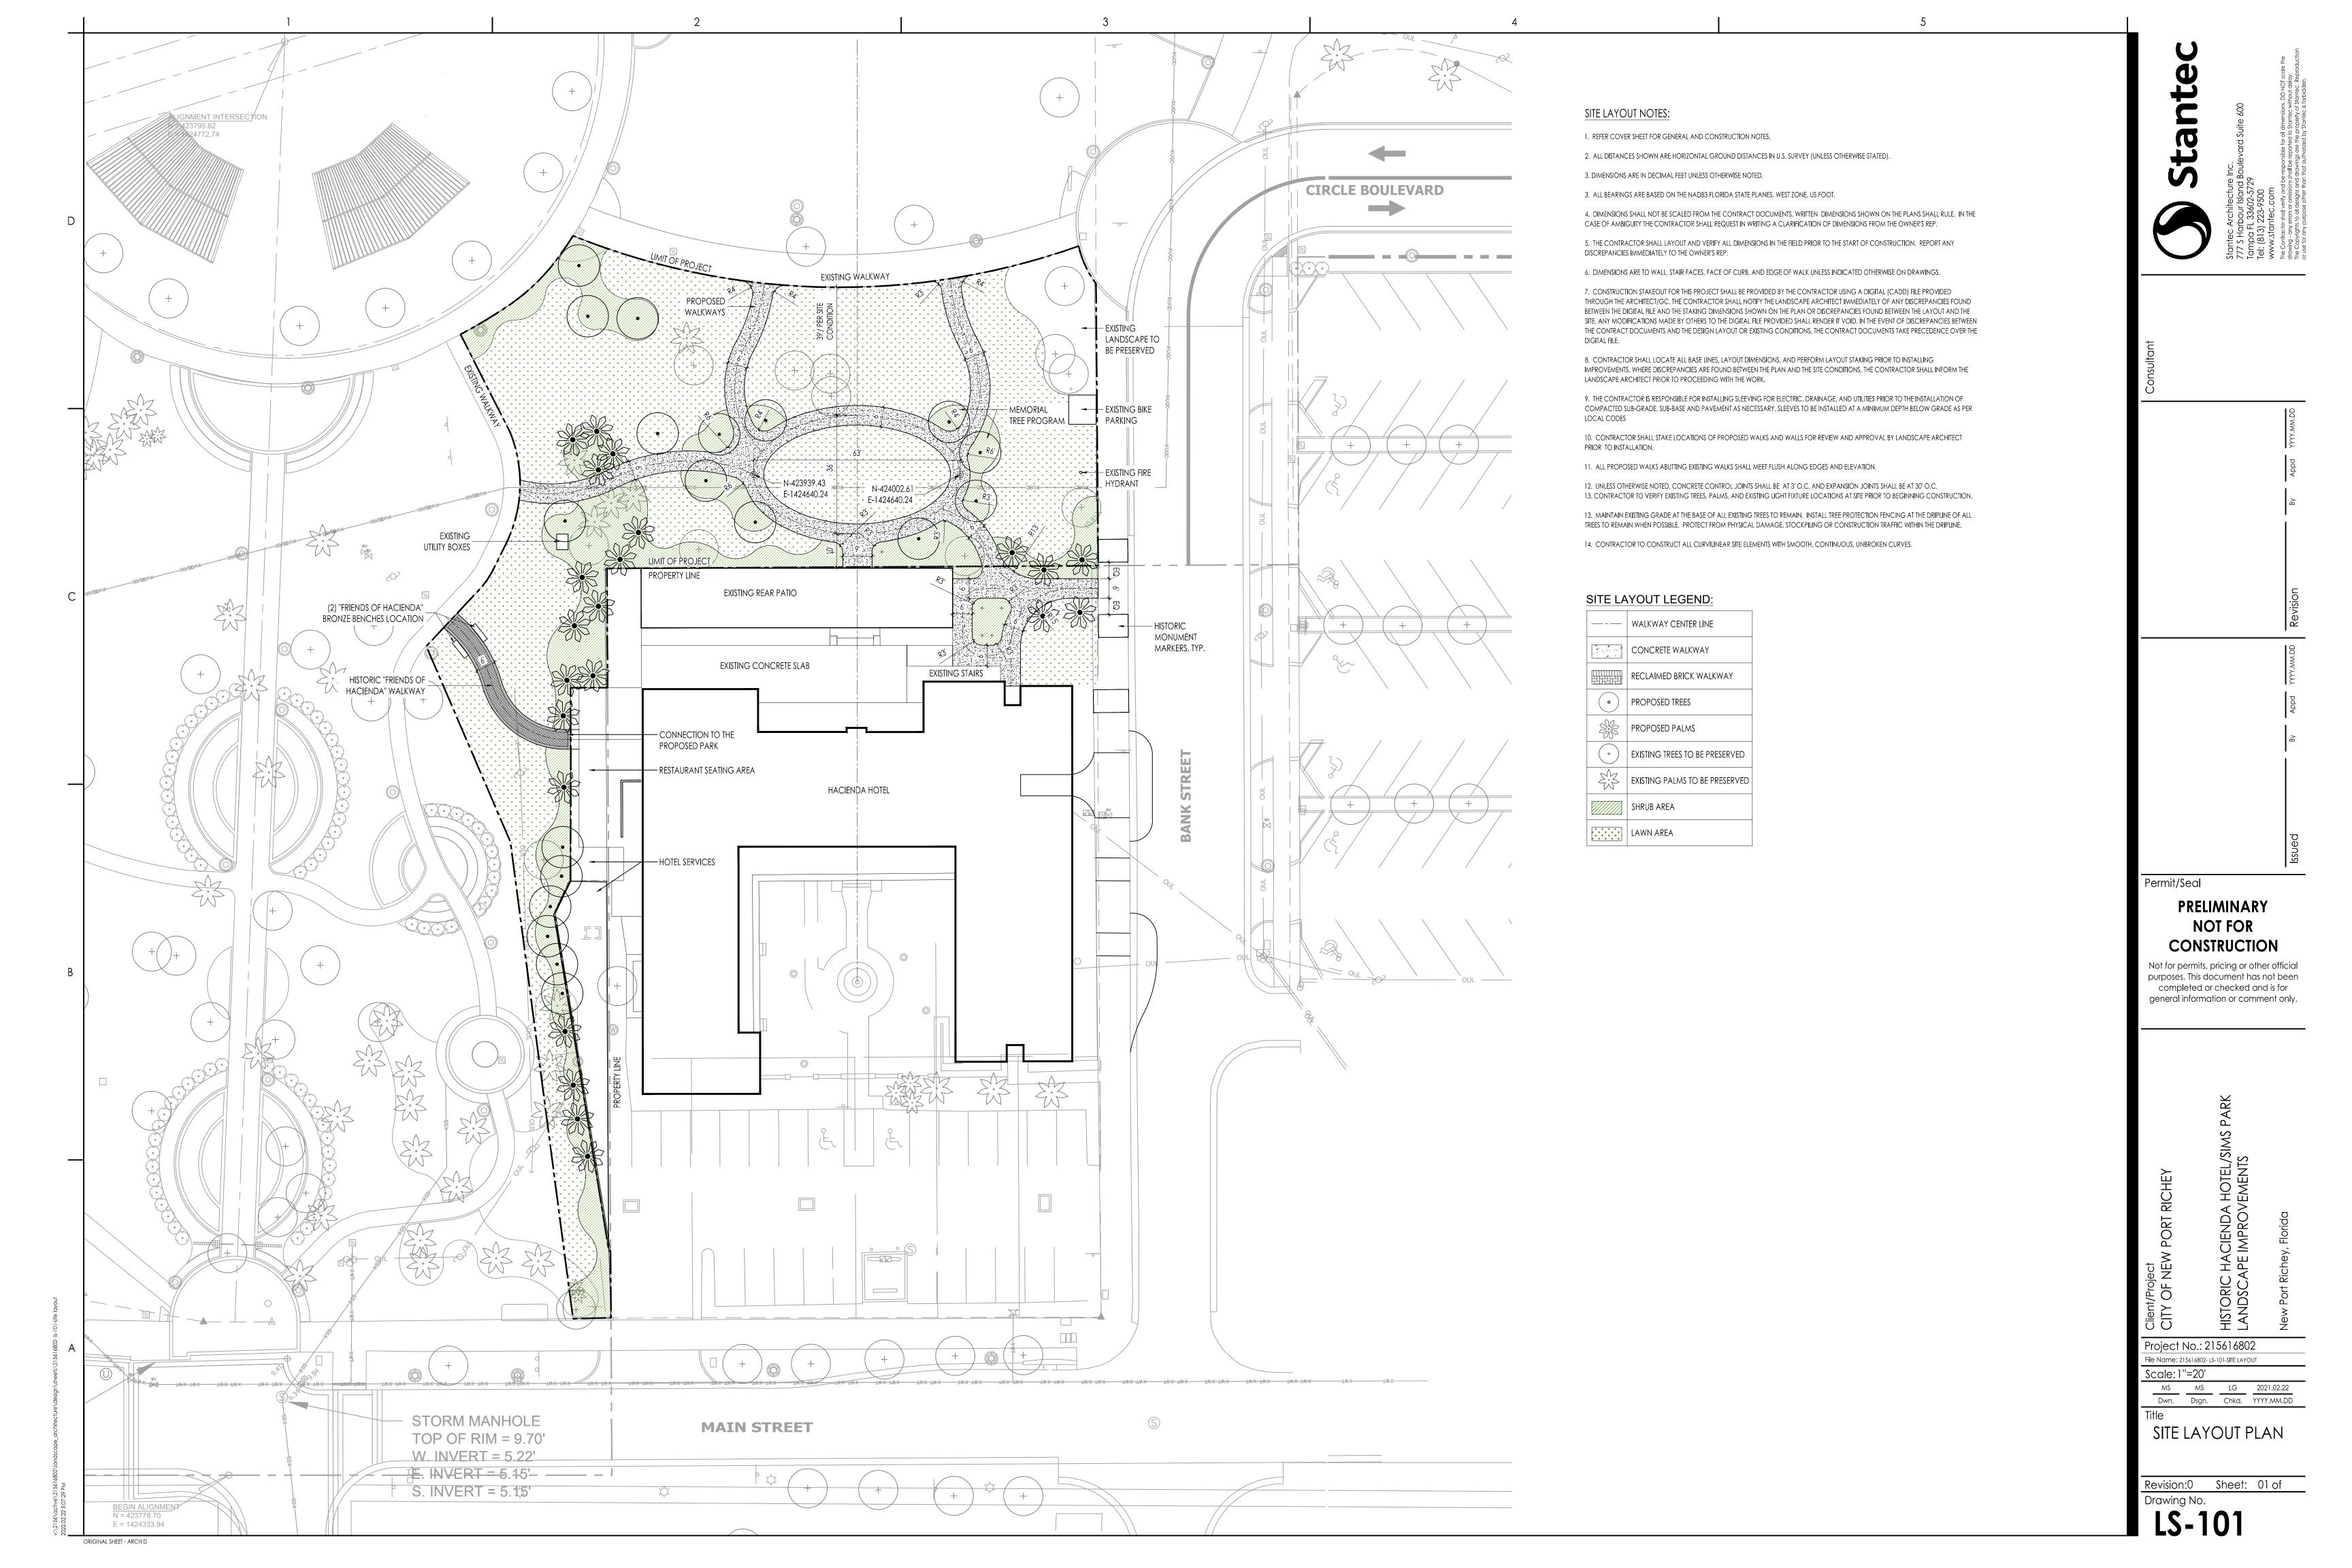


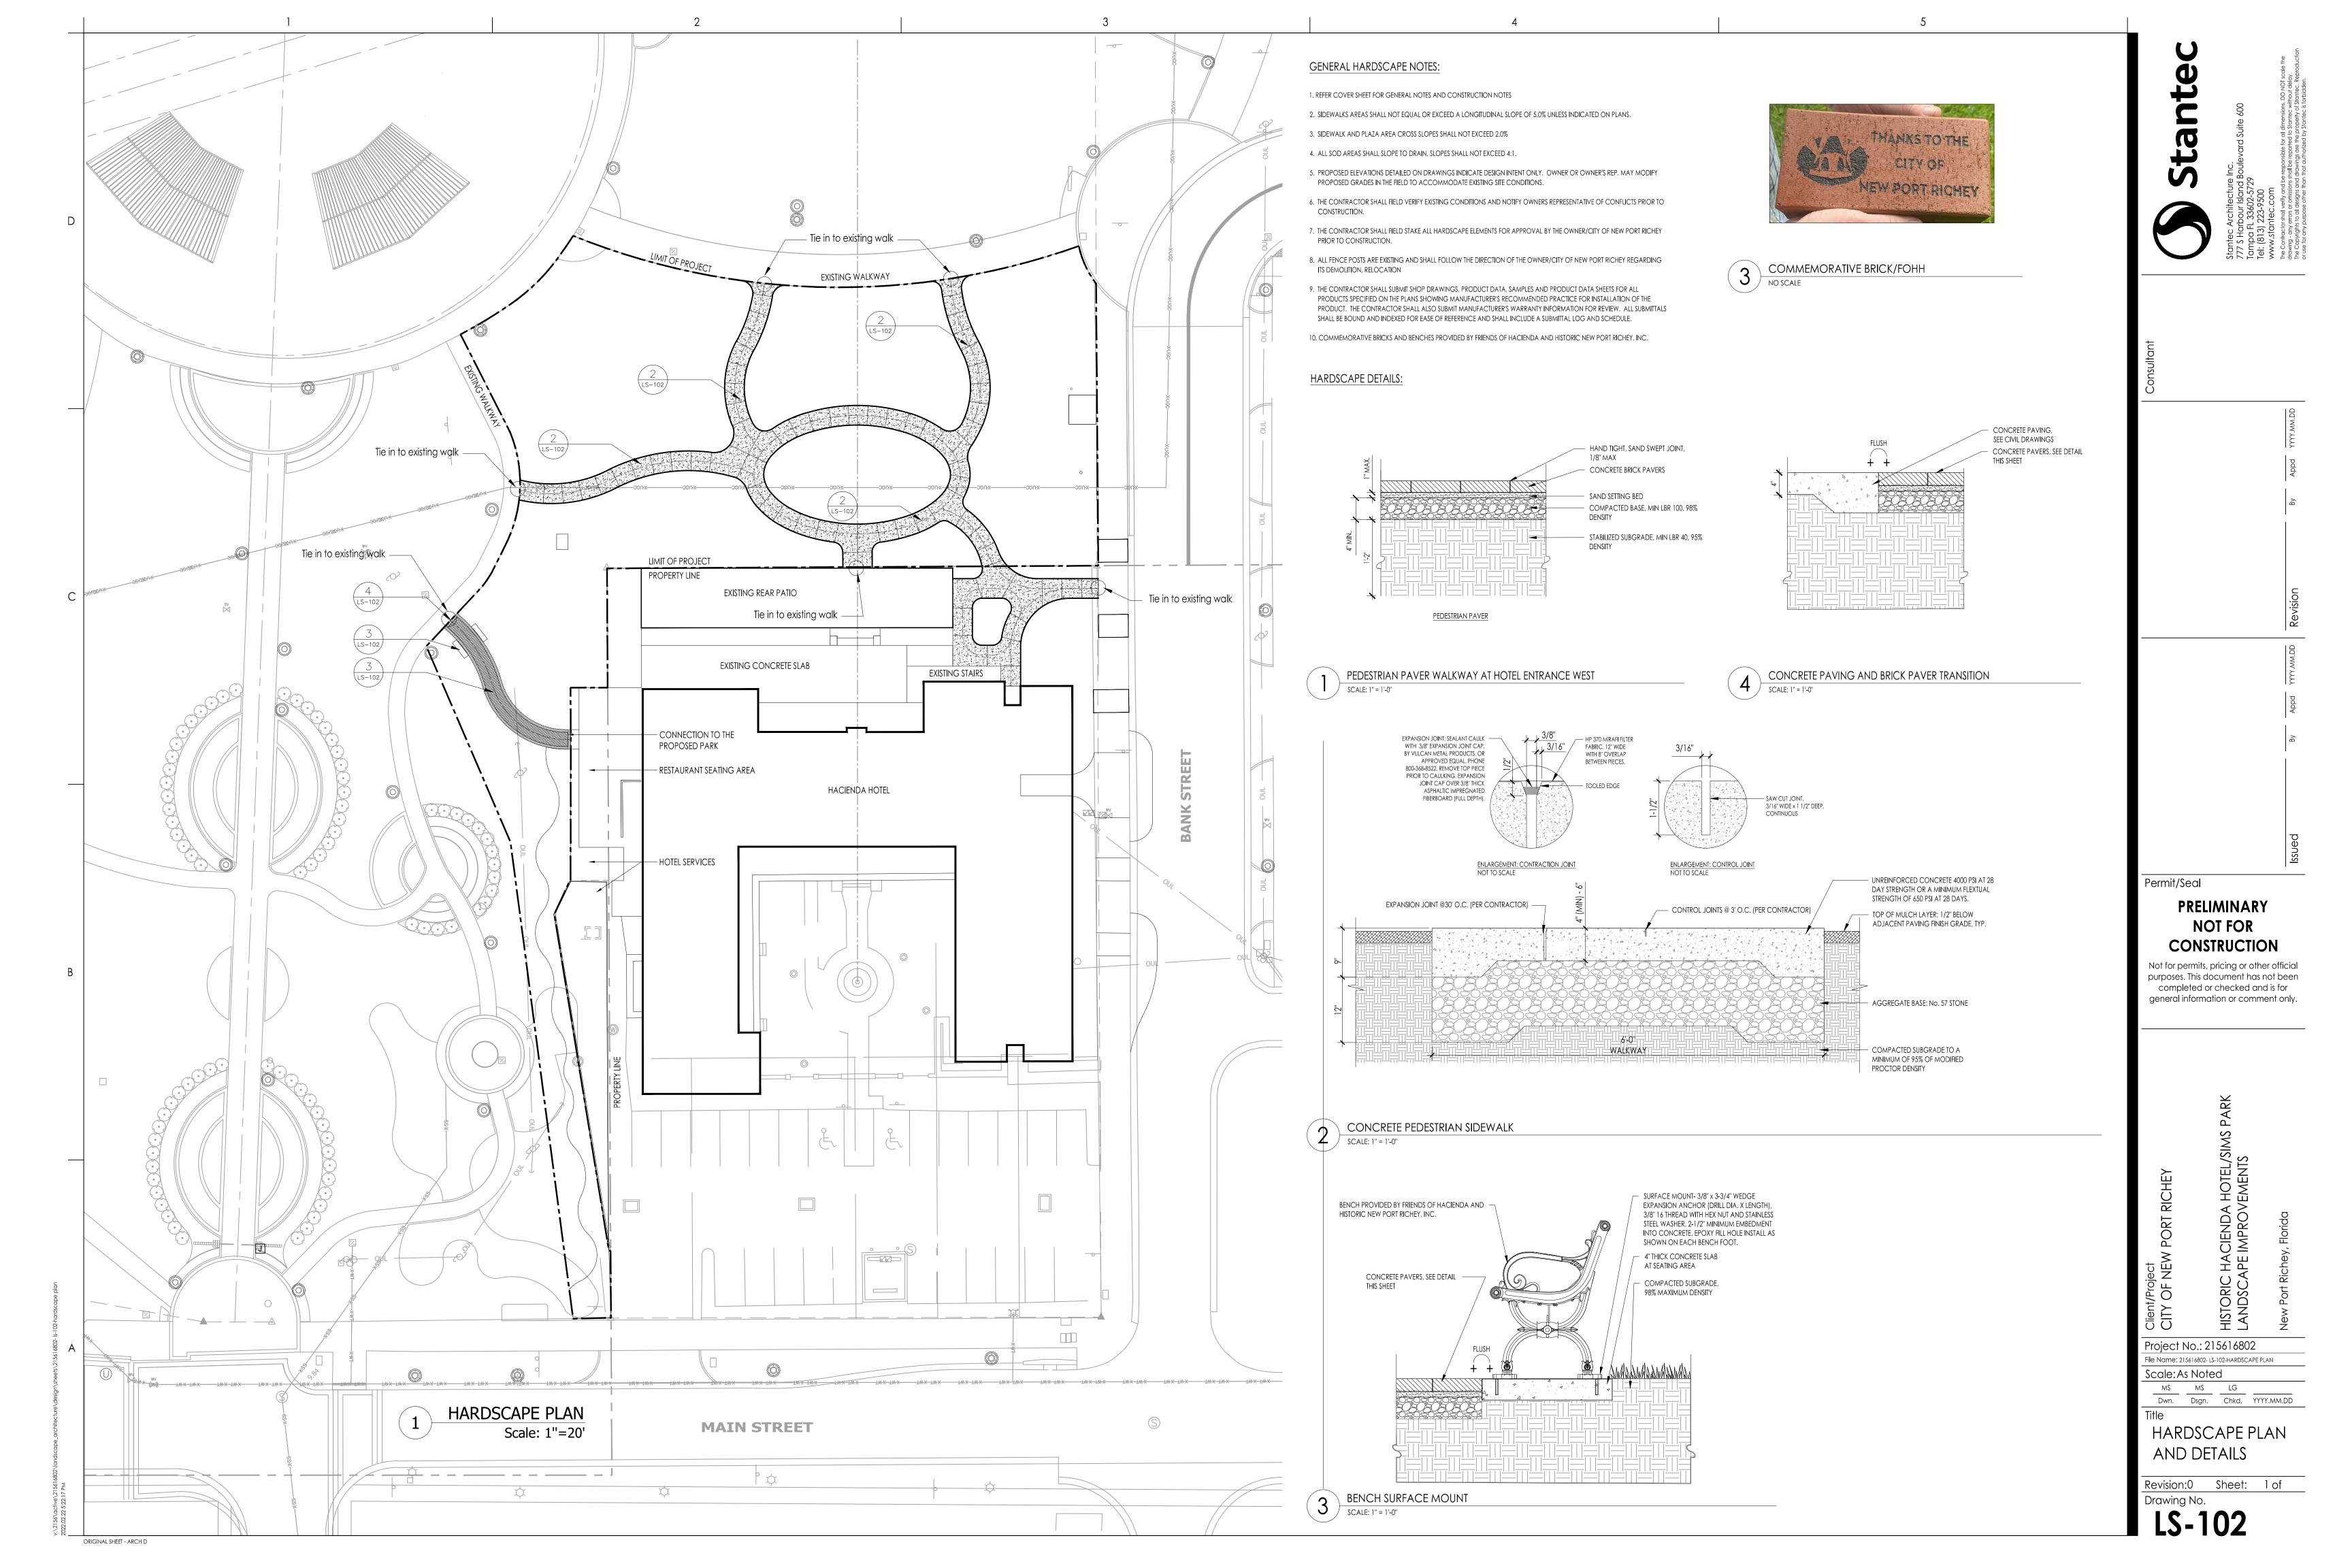

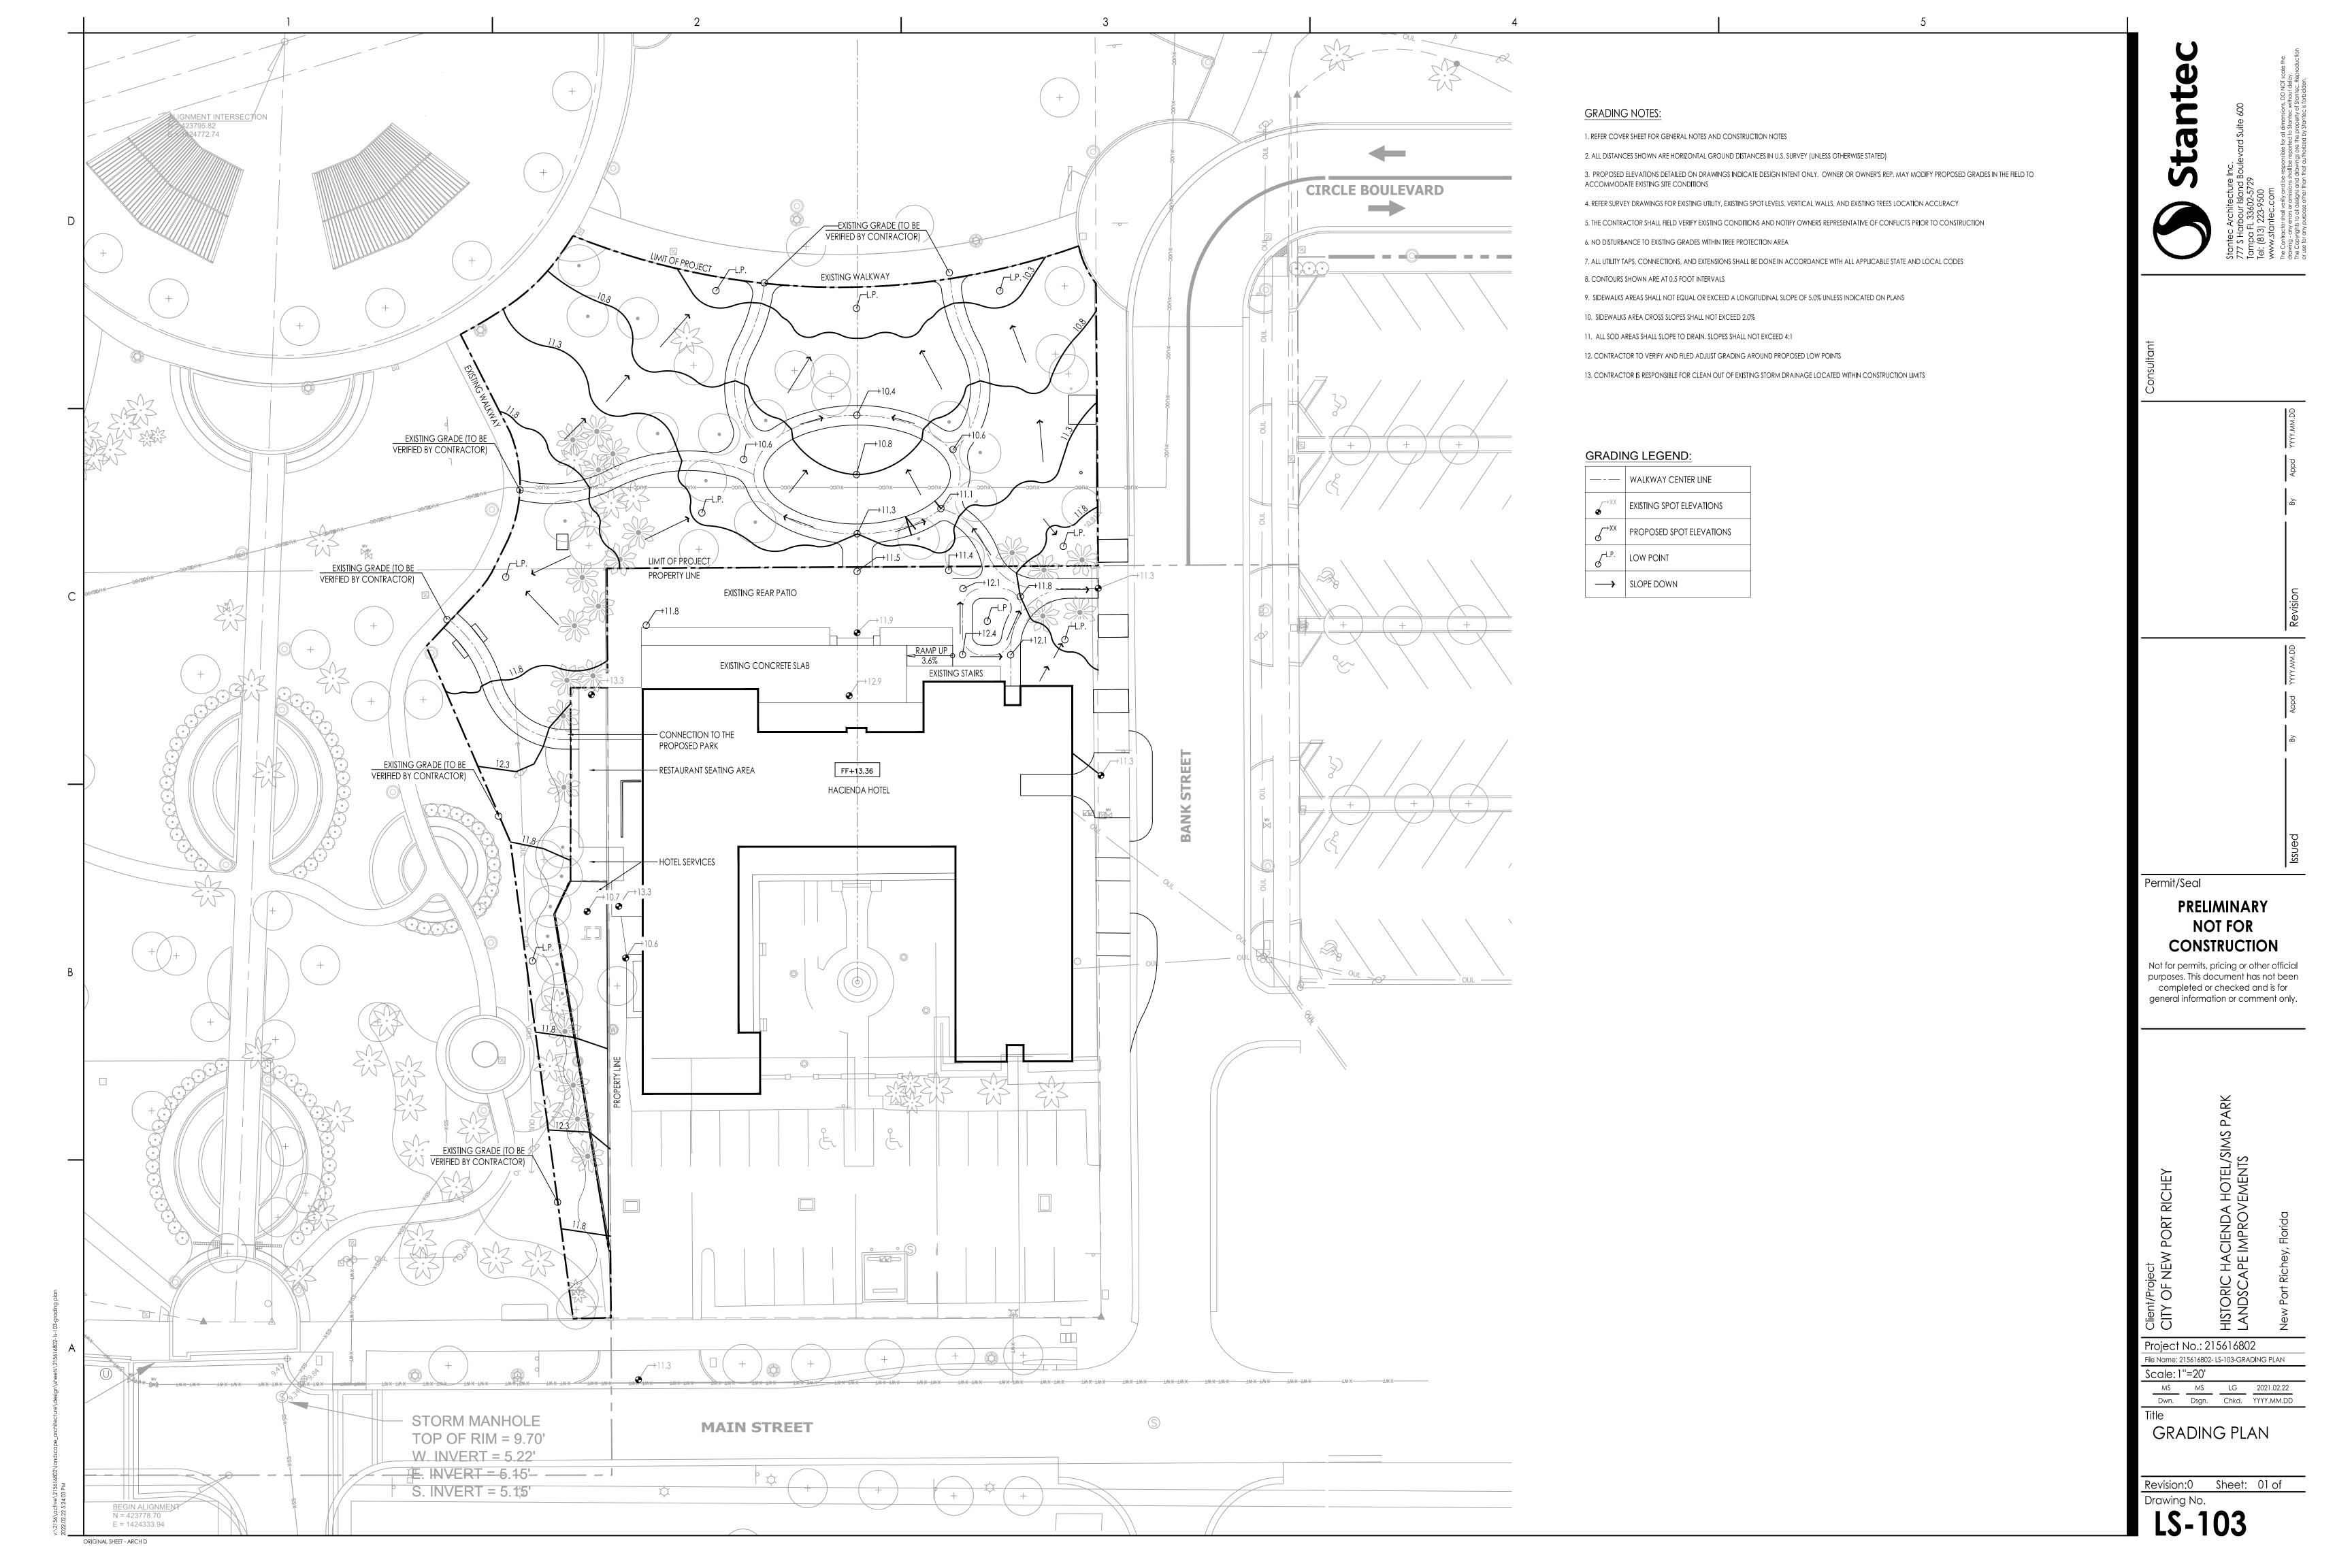

RIBBON PALMS ARE TO BE SLICK (CLEAR-WOOD) FROM THE BASE OF THE PALM TO 4' BELOW CLEAR TRUNK HEIGHT. FINAL TREE STAKING DETAILS AND PLACEMENT TO BE APPROVED BY LANDSCAPE ARCHITECT


LARGE TREE PLANTING DETAIL

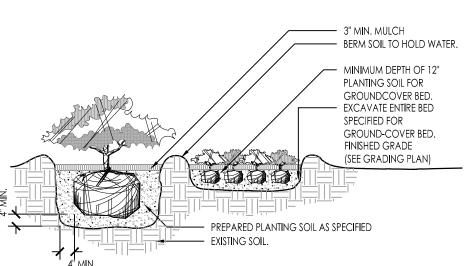

NOTES:

1. PLANT MATERIAL SHALL BE PLANTED 2" HIGH WITH SOIL MOUNDING UP TO THE TOP OF ROOT BALL 2. WHEN GROUNDCOVERS AND SHRUBS ARE USED IN MASSES, ENTIRE BED TO BE EXCAVATED TO RECEIVE PLANTING SOIL AND PLANT MATERIAL - EXCEPT WHEN SPECIFIED.

SHRUB AND GROUNDCOVER PLANTING DETAIL

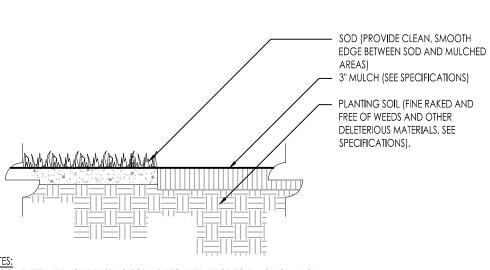

NOTES:


1. COMPLETELY REMOVE EXISTING SOD AS REQUIRED PRIOR TO PLACING MULCH. 2. ALL MULCH SHALL BE PEST AND INSECT FREE.

MULCH APPLICATION DETAIL

TREE PROTECTION STANDARDS

- 1. No attachments other than flagging or similar material identifying protected trees shall be attached to trees designated to remain on the site.
- 2. It shall be unlawful to undertake the following activities within the dripline of a tree remaining on the site, unless otherwise approved by the Administrator: remove vegetation, except by hand, or place soil deposits, debris, solvents, construction material, machinery or other equipment of any kind, or undertake any other land alteration or construction activity which would cause the tree to die within a period of two years.
- 3. The compaction, filling or removal of soil or the use of concrete, asphalt or other paving material shall be prohibited within the dripline of a tree that is to remain on the site, unless otherwise approved by the Administrator.
- 4. All tree roots existing within approved improvement areas and originating from a protected tree shall be severed clean at the boundary of the area to be preserved around the tree.
- 5. Trimming of protected trees shall be undertaken in accordance with the American National Standards Institute (ANSI) A 300 Pruning Standards.
- 6. Protective barricades shall be placed around all protected trees and grand trees during site clearing to create a protective radius and shall remain in place until land alteration, site clearing and construction activities are complete. Barricades for the protective radius shall be erected at a minimum distance of ten (10) feet from the edge of trunk of protected trees and twenty (20) feet from the edge of trunk of grand trees.
- 7. A minimum distance of ten (10) feet from all protected trees and twenty (20) feet from all grand trees shall be maintained when installing underground utilities. If this results in unreasonable hardship, a soil auger shall be used to tunnel under the root systems.
- 8. Installation of artificial barriers such as protective barricades, fences, posts or walls shall not destroy or irreversibly harm the root system of protected trees and grand trees. Footers for walls shall end at the point where larger roots are encountered, and the roots shall be bridged. post holes and trenches located close to protected trees or grand trees shall be adjusted to avoid damage to major roots.
- 9. All roots to be removed during the site clearing phase shall be severed clean at the perimeter of the designated protective radius.
- 10. A two-inch layer of mulch shall be applied over the surface of exposed roots of protected trees and grand trees during the site clearing phase.
- 11. A protective dry well and drainage / aeration system shall be provided where protected trees or grand trees will be adversely affected by raising the grade.
- 12. A protective retaining wall shall be constructed at the perimeter of the protective radius around a protected tree or grand tree where the protected tree or grand tree will be adversely affected by lowering the grade.
- 13. All trimming of protected trees and grand trees during development shall be done by a qualified, certified arborist.

TREE BARRICADE REQUIREMENTS

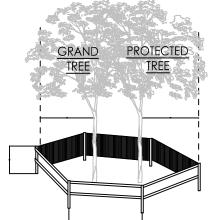

Protective barriers are used during land alteration and construction activities to protect trees and natural areas to be retained on a site.

Protective barriers must be erected around trees to be retained within an area where land alteration and construction activities will occur as well as along natural areas where such areas are adjacent to permitted land alteration or construction activities. A protective barrier must remain in place until the land alteration and construction activities are completed or until commencement ot grade tinisning, sodding and landscaping. No ground disturbance shall occur within the barricaded area. The following represents the City's minimum protection barrier specifications.

- 1. Trees To restrict access into the area within the rootzone of a tree, a physical structure not less than 3 feet in height, comprised of wood or other suitable material, is placed around the tree at the minimums shown above, except where land alteration or construction activities are approved within the rootzone. Vertical members shall be made of a minimum of 2x2 wood or 5/8" steel reinforcement bar, at least 3' in height and installed to a minimum depth of 1' below grade. Spacing between vertical members shall be no greater than 6'. Horizontal members shall be made of a minimum 1x2 wood or solid fencing material, such as orange or chain link fencing, and be a minimum of three feet in height.
- 2. Natural Areas To restrict access into areas where land alteration and construction activities are not authorized, a physical structure not less than 3 feet in height is placed along the perimeter of such areas. Upright stakes of no less than 2" x 2" lumber spaced no more than 25' apart and connected by extra strength filter fabric at 6' maximum spacing without wire support fence. Other methods of demarcation will be considered depending upon the characteristics of the site.

LANDSCAPE NOTES

- All landscape construction shall conform to the minimum landscape requirements of Plant City. Contractor to comply with all state and local code requirements.
- Contractor is responsible for determining all utility locations and installing facilities so as to not conflict. All damage to existing utilities or improvements caused by contractor shall be repaired at no additional cost to the owner.
- Soil testing shall be performed in all planting areas (including sodded areas) prior to construction with results submitted to landscape architect. Samples shall be taken from each different planting area, from soil which is to remain. Soil amendments shall be added as necessary to meet the following parameters:

pH Range 5.5 - 6.5 Organic Matter 4 - 10% Calcium 60-70% 10-20% Magnesium Phosphorus Equal to Potassium 3-5% Potassium Soluble Salts/ less than 2 mmho/cm Conductivity

After amendments have been added, resubmit results to the landscape architect for

- All planting beds shall be excavated a minimum of 6" and backfilled with planting mix. Reference planting details for actual depth of required excavation. All sodded areas shall have a minimum of 2"
- of topsoil on well drained sub-soil. Contractor shall grade all landscape areas, eliminating all surface irregularities, depressions, vegetative matter, sticks, stones, and other debris, and remove them from site.
- Furnish to the owner a unit price breakdown for all materials. The owner may, at there discretion, add or delete from the materials utilizing the unit price breakdown submitted.
- All new plant material shall be graded Florida #1 or better as defined by the latest edition of "Florida Grades and Standards for Nursery Stock". 10. Caliper measurement shall be taken six inches above ground level if specification is four inches or less
- and twelve inches above ground level if specification is greater than four inches. All plant material shall be nursery grown and 100% acclimatized to local conditions.
- Submit the following: Mulch, planting soil, soil sample analysis, plant material.
- Provide a representative sample of each plant material type for approval by the landscape architect prior to installation. Approvals may be granted through representative photos at landscape architect's
- 14. All new plant material shall be guaranteed for 1 year, from time of final acceptance of project, any plant material not in a healthy growing condition will be replaced by the contractor, at no additional cost to the owner within 10 days of notification. Extend warranty period an additional 6 months beyond the original warranty period, for all replacement plant material. Warranty is null and void for plant material which is damaged or dies as a result of "Acts of God" limited to hail, freeze, lightning, automobile damage, and winds exceeding 75 mph as defined by the National Weather Service. All trees that lean or are blown over, caused by winds less than 75 mph, will be re-set and braced by the contractor at no additional cost to the owner.
- All trees, shrubs and ground covers shall be of the sizes as called for in the Plant Schedule. Where there is a discrepancy either in quantities, plant names, sizes or specifications between the plan and Plant
- Schedule, the plan takes precedence. 16. No plant material will be accepted showing evidence of cable, chain marks, equipment scars, or otherwise damaged.
- 17. Plant material will not be accepted when the ball of earth surrounding its roots has been cracked, broken or otherwise damaged.
- 18. New plant material to be installed will be field adjusted to accommodate existing plant material such as overhead canopy trees, under-story trees and shrubs or ground cover. This will insure existing plant material to remain in its natural state. Therefore, no existing plant material will be altered by removing,
- cutting, trimming or destroying in order to install new plant material. Root-prune all non-container grown trees a minimum of (8) weeks prior to planting. See detail. Note
- size of planting pits on planting details. All protected trees, if any, shall be trimmed in a manner consistent with the "American National
- Standard for Tree Care Operations, ANSI, A300, current edition". 21. Protective barricades shall remain in place until land alteration and construction activities are
- 22. During land alteration and construction activities, it shall be unlawful to remove vegetation by grubbing or to place soil deposits, debris, solvents, construction material, machinery or other equipment of any kind within the drip line of a tree to remain on the site unless otherwise approved by
- 23. All planting holes to be hand dug except where machine dug holes will not adversely effect or
- damage utilities or improvements. 24. Planting soil to be a weed free mixture of 50% coarse native sand and 50% peat, pH between 6.5 and
- 7.5. All plant material to receive planting soil as per details.
- 25. Use 21 gram Agriform 20-10-5 planting fertilizer tablets per manufacturer's specifications for all plant 26. Apply pre-emergent weed killer over grade prior to mulching. Use rates recommended for specified
- Mulch tree rings and shrub and ground cover beds with required mulching material a minimum of 2" deep or as otherwise noted on plans immediately after planting. Thoroughly water mulched areas. After watering, rake mulch to provide a uniform finished surface. Mulched areas shall not exceed 3" in
- depth. Hold mulch back from the base of trees and shrubs a minimum of 3". 28. Contractor shall stake & guy all trees and palms per City specifications and per the appropriate detail. Contractor is responsible for the maintenance and/or repair of all staking and guying during warranty
- 29. All waste, objectionable material, and excess fill shall be removed and disposed of on a daily basis
- off-site in a legal manner.
- Any areas subject to erosion must be adequately stabilized with vegetation material that will, within a reasonable time frame, deter soil disturbance.
- Coordinate the removal of erosion control fencing with site contractor while performing final planting. Sodding, plugging sprigging or seeding is acceptable for stabilization; however, sodding may be required in areas of erosion-prone soils or where slopes are greater than 5:1. Vegetation other than

grass is acceptable unless otherwise specified.

Permit/Seal

PRELIMINARY NOT FOR CONSTRUCTION

Not for permits, pricing or other official purposes. This document has not been completed or checked and is for general information or comment only.

Project No.: 215616802 File Name: 215616802- LS-501-PLANTING DETAILS

Scale: As Noted

MS MS LG

Dwn. Dsgn. Chkd. YYYY.MM.DD PLANTING DETAILS

AND NOTES Revision:0 Sheet: 1 of

ORIGINAL SHEET - ARCH D

NOTES:

1. ALL SHRUBS AND GROUNDCOVER MASSES TO USE TRIANGULAR SPACING EXCEPT WHERE NOTED.

2. CONTRACTOR SHALL ASSURE FREE DRAINAGE / PERCOLATION OF ALL PLANTING PITS PRIOR TO

TYPICAL PLANT SPACING DIAGRAM

REFER TO PLANT LIST FOR INDIVIDUAL PLANT SPACING.